




Proposed Retirement Living

3 Quarry Road DURAL

Landscape Design Intent

Revised 11.06.2024

Deep Rainforest=

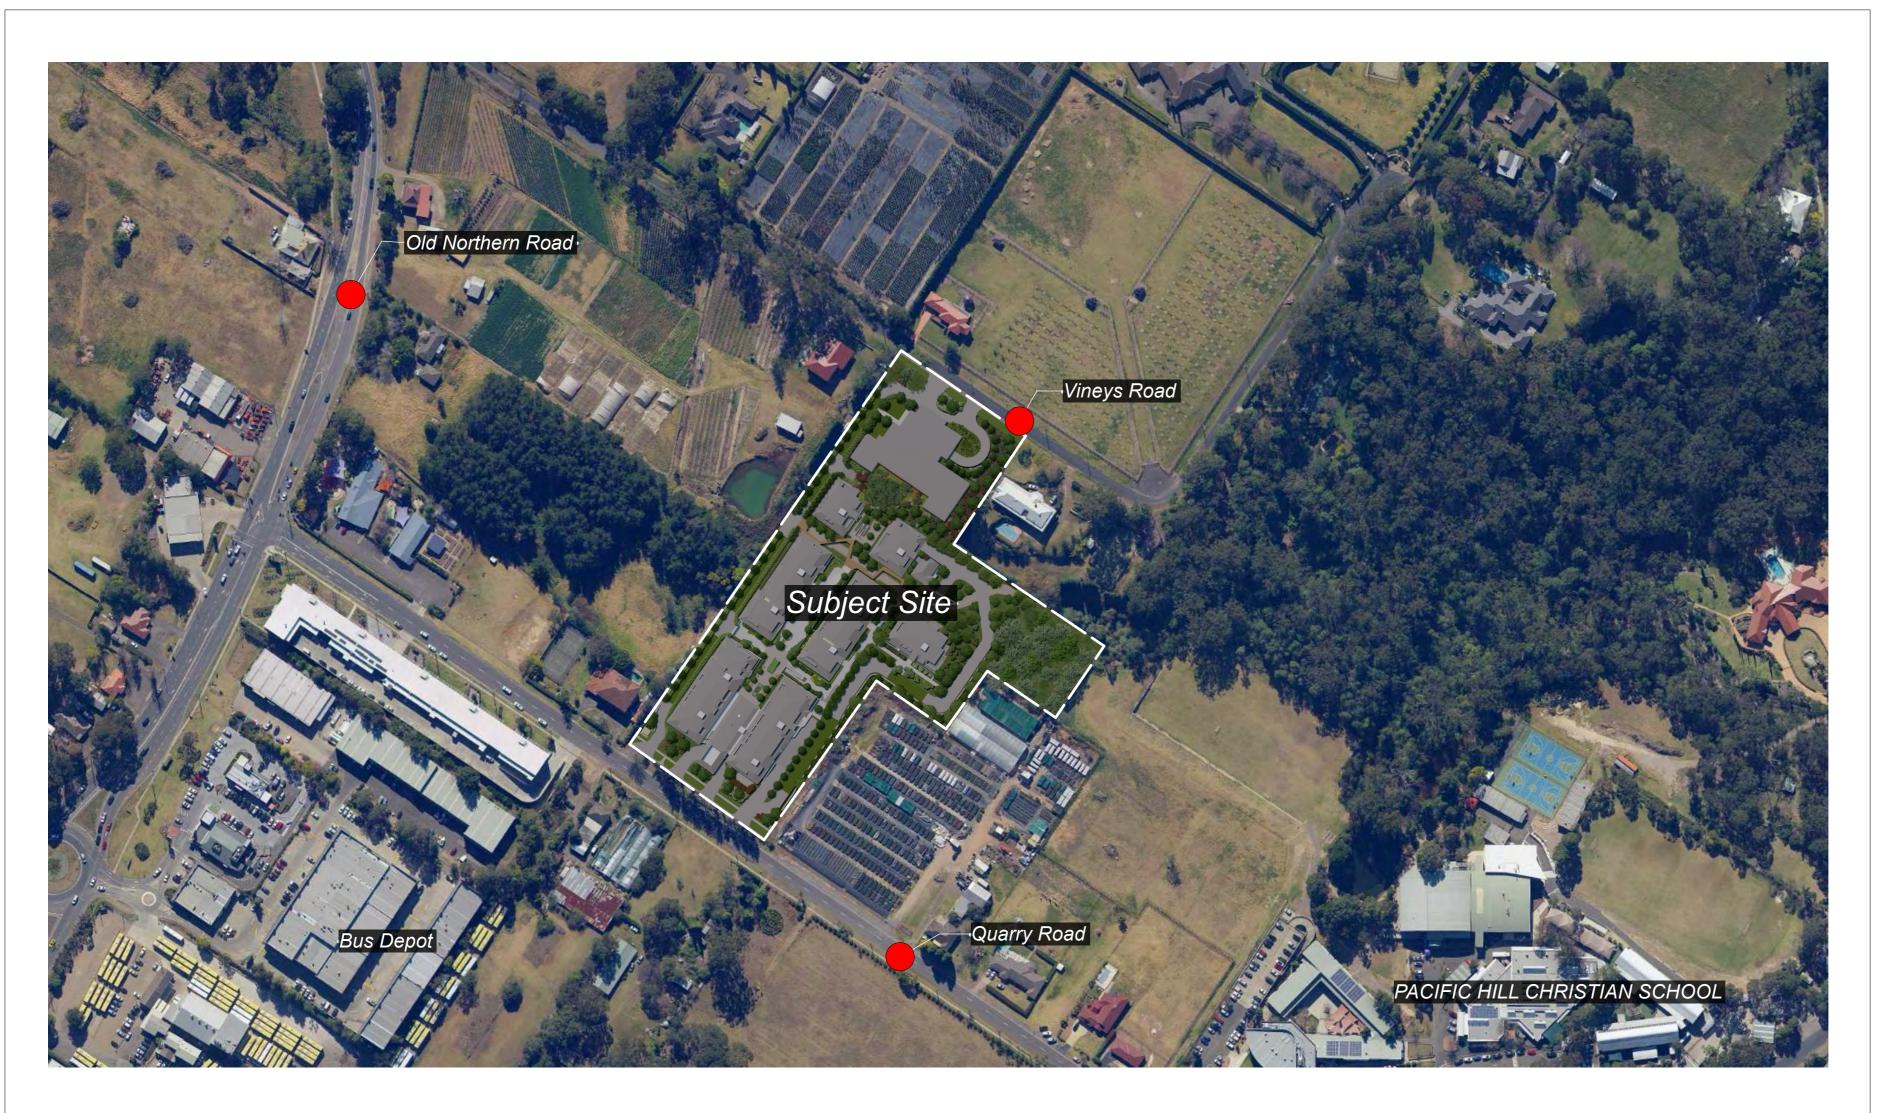





B 05.06.24 Added turf, further detailsA 21.12.23 General revisions

NO. DATE NOTE

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Client LIVING CHOICE AUSTRALIA

Address 3 QUARRY RD DURAL NSW

Project


RÉSIDENTIAL CHOICE

Drawing Locality plan



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Scale		
Date 21.12.	23	
North	Job No. SLI22-34	Dwg No.
	Issue.	Sht-3



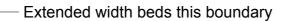


KEY

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- 8. Low Planting to Roof of Basement/Pool egress


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Issue.


overall

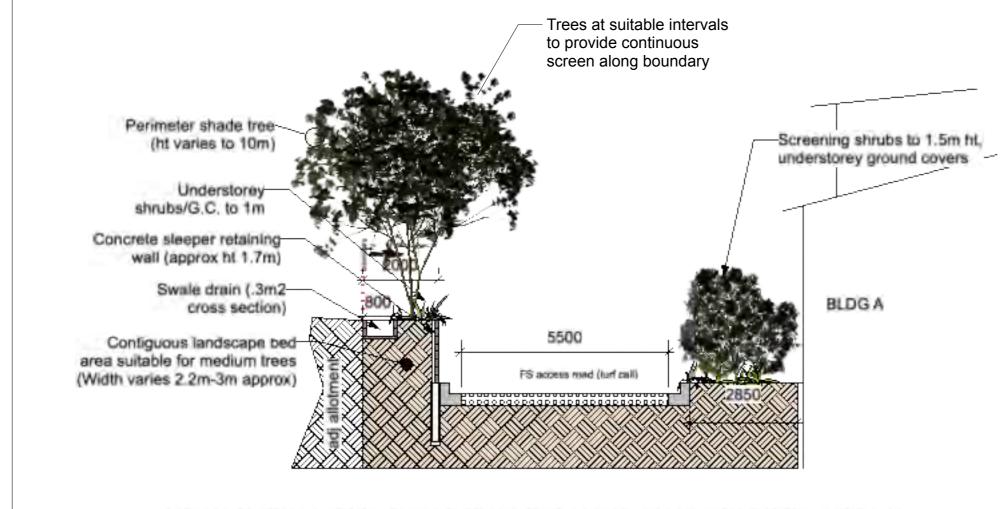


NW BOUNDARY/FIRE SERVICE ACCESS SECTION 1 VIEW

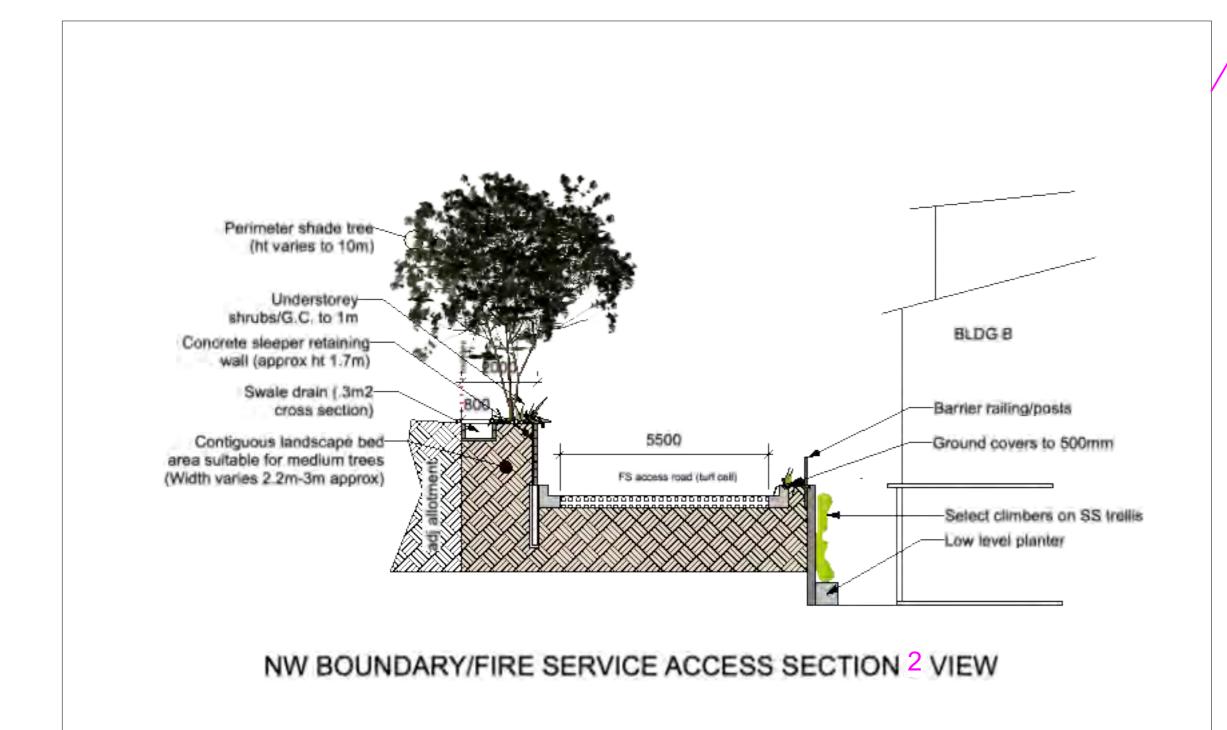

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A 21.12.23 General revisions
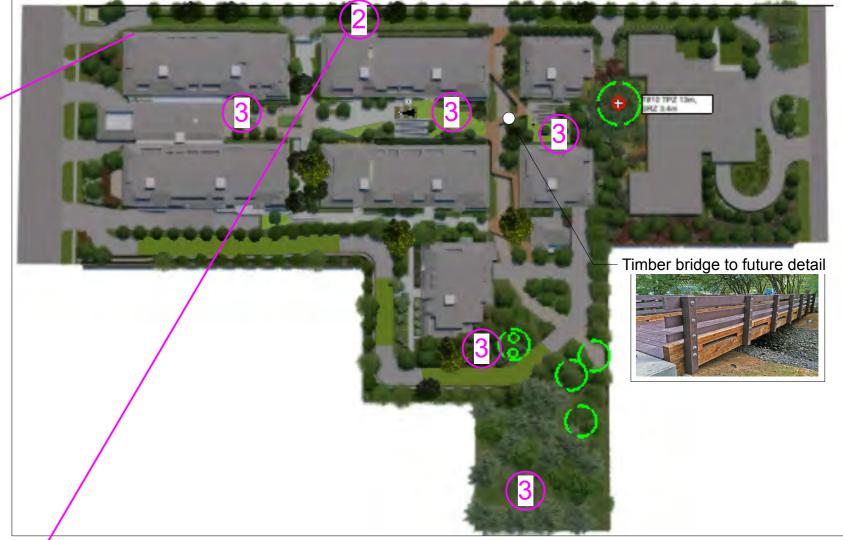
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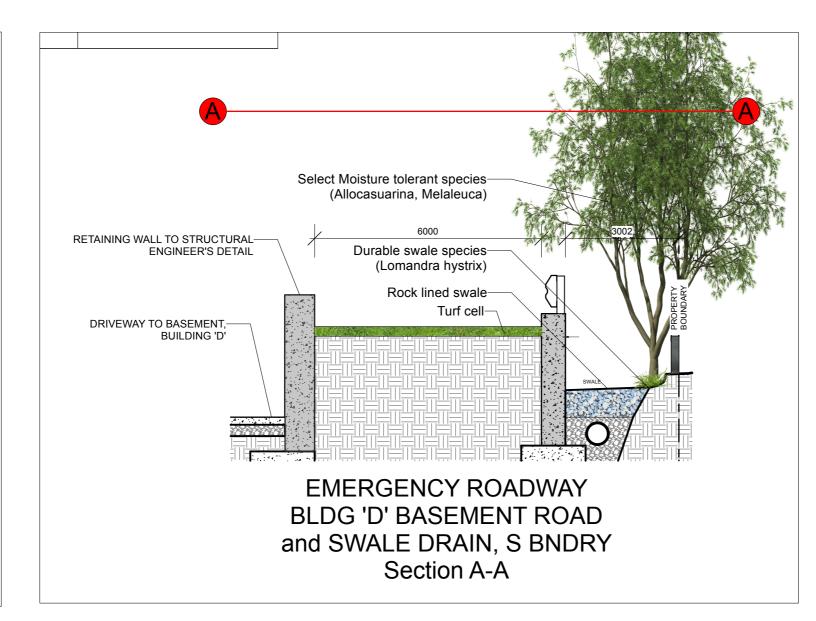
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Drawing SECTION VIEWS 1

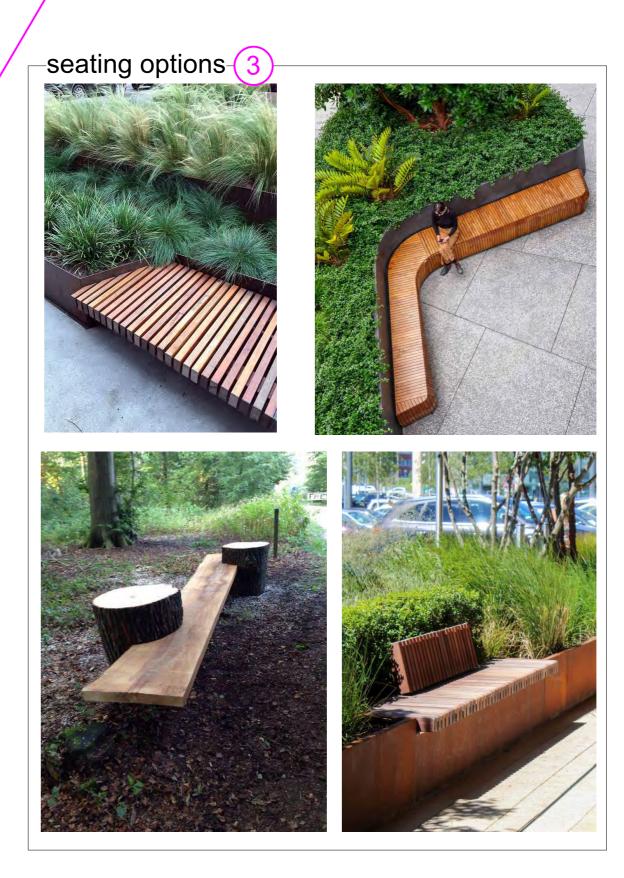


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Scale		
Date 21.12	2.23	
North	Job No. SLI22-34	Dwg No.
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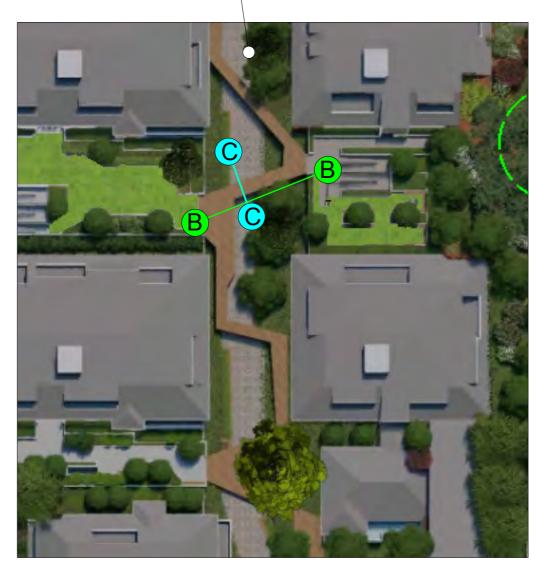


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BOARDWALK LAYOUT Scale 1:500

5/6/24 Added details

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Drawing SECTION VIEWS 2

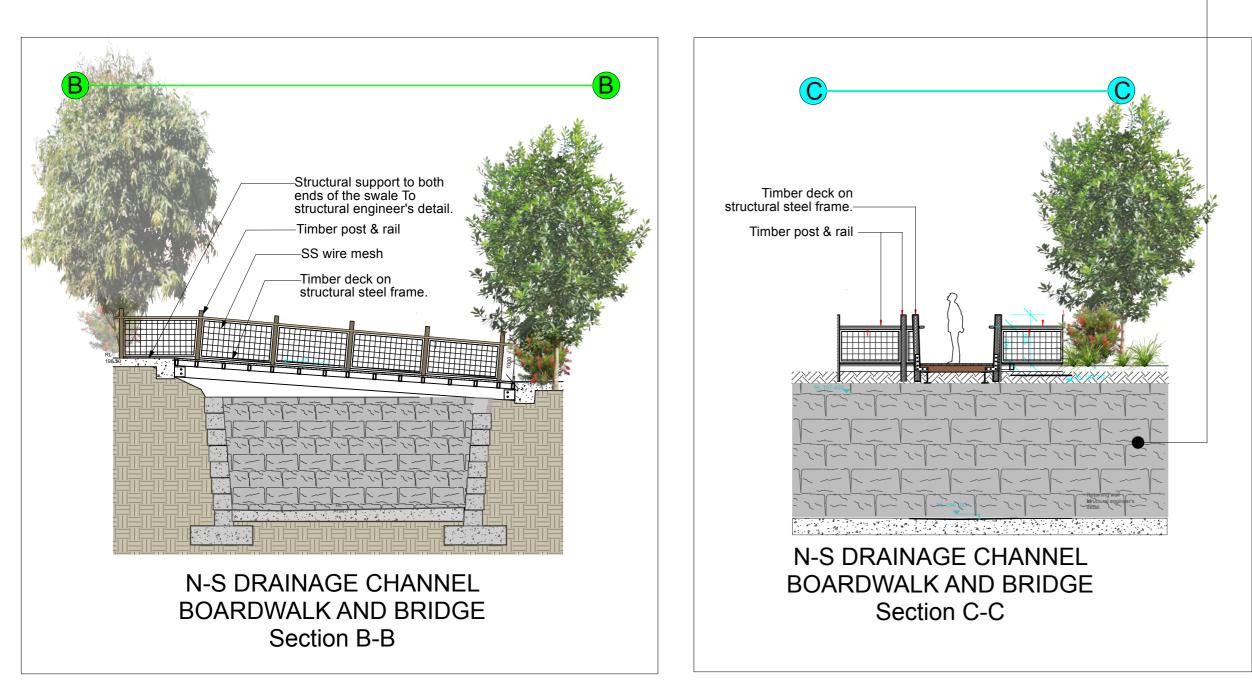


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Scale




North Job No. SLI22-34 Issue. Dwg No. Sht-4

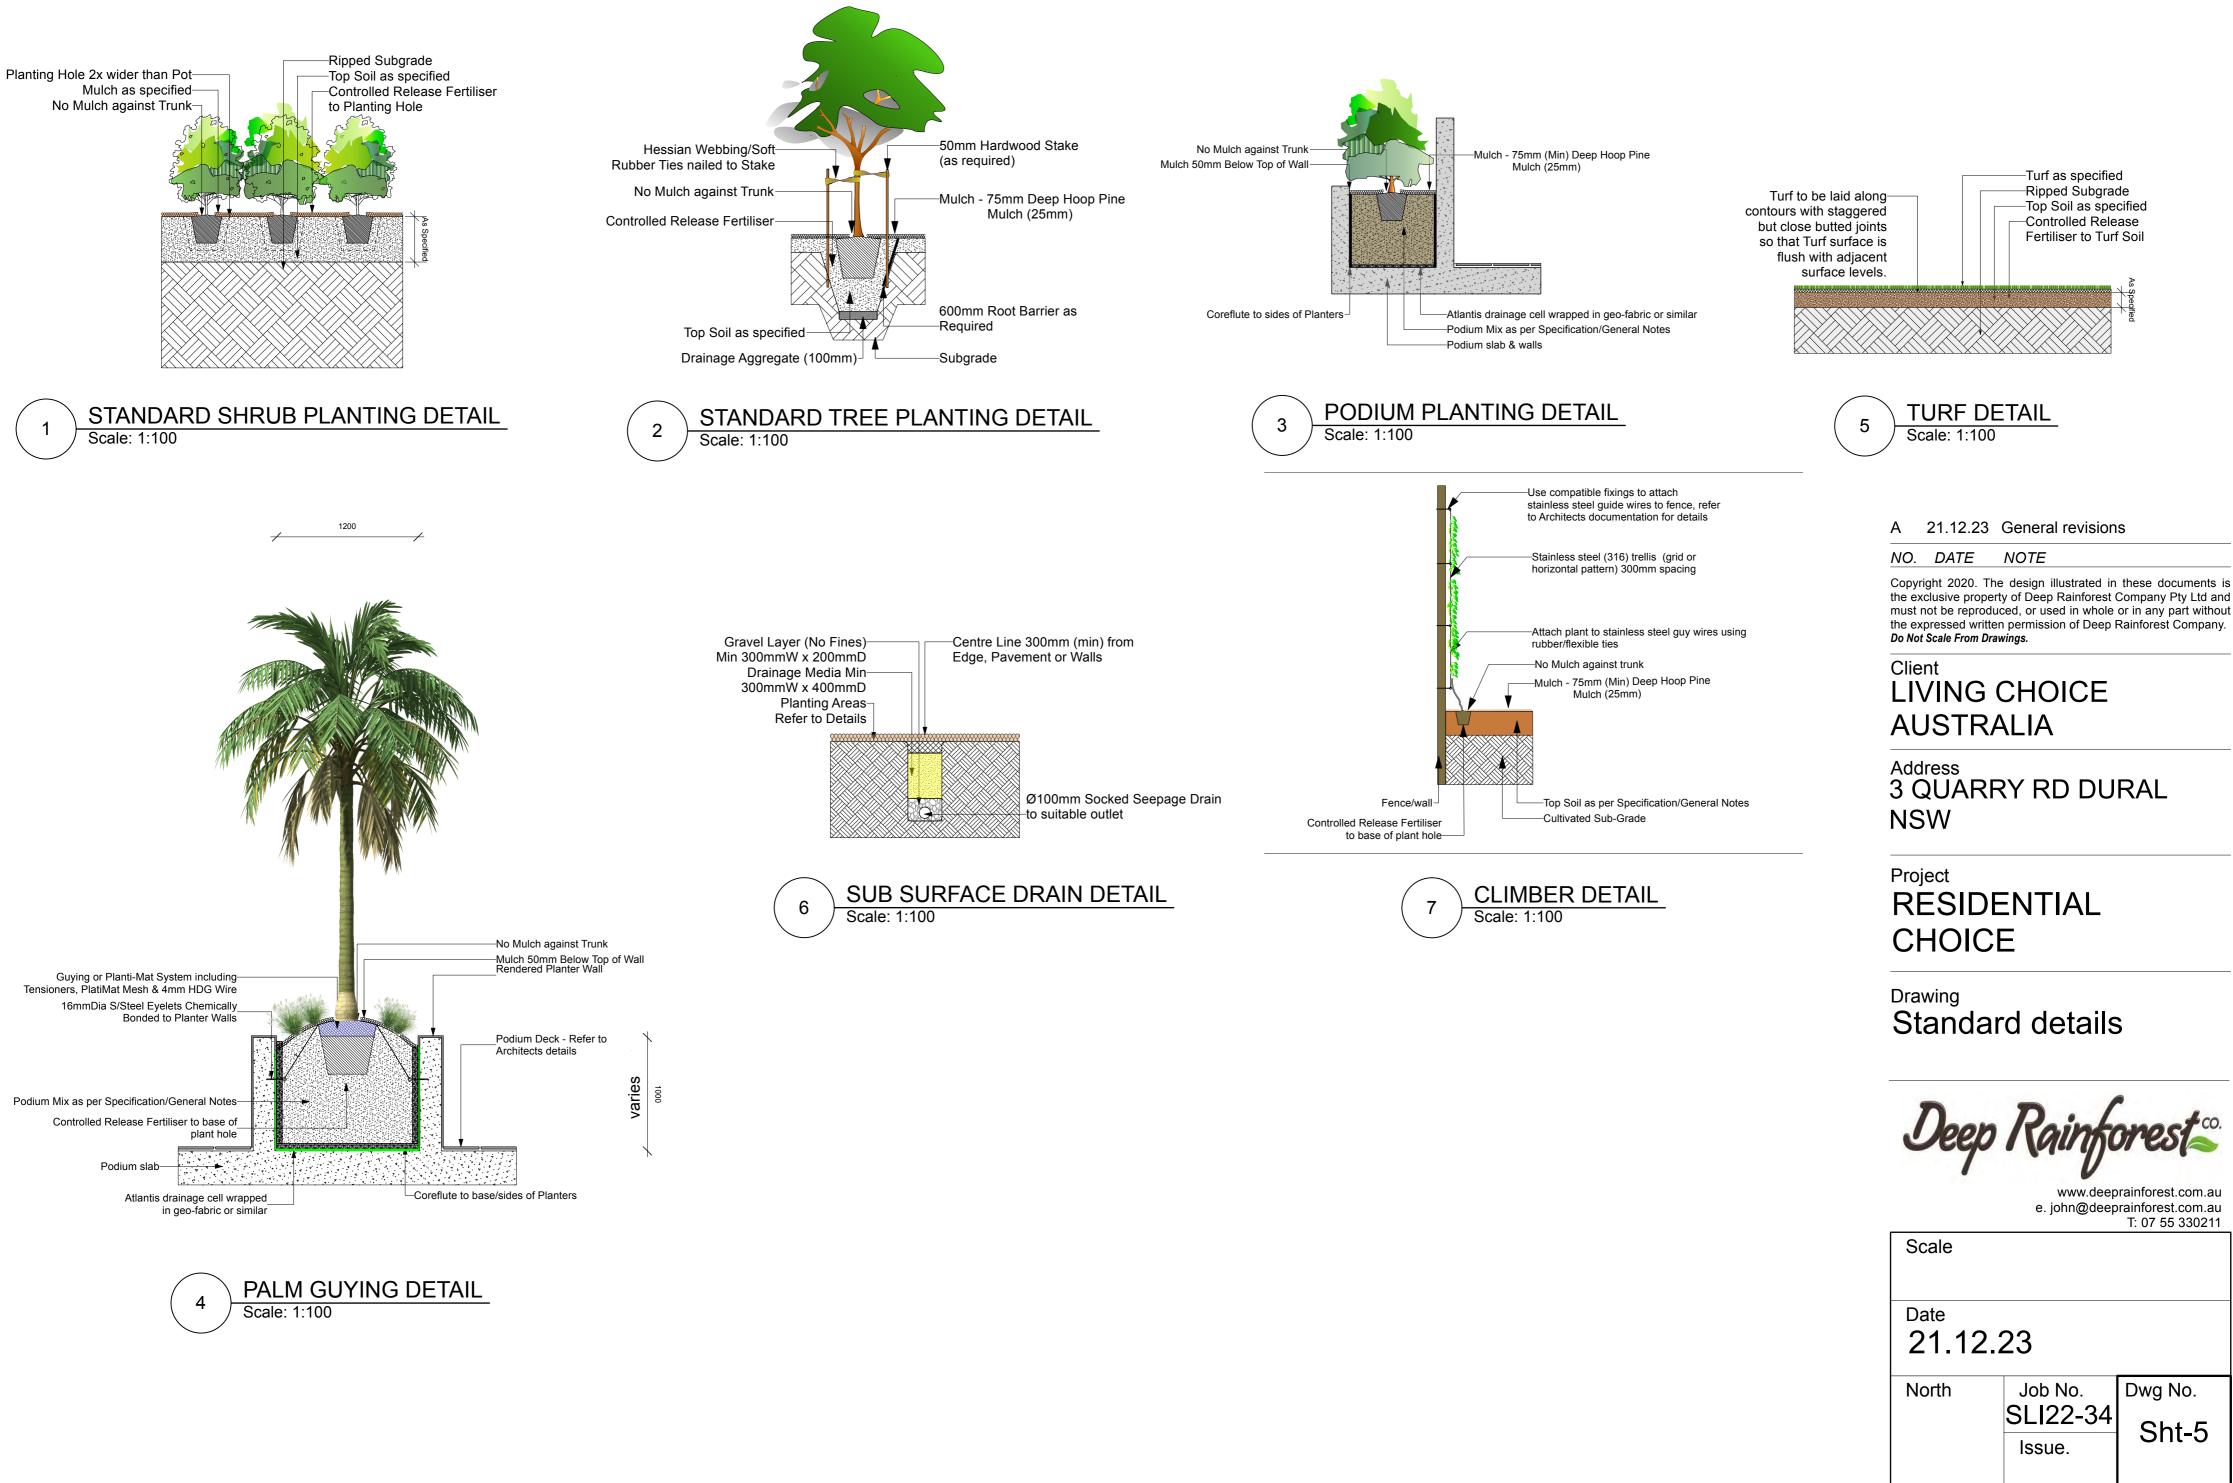

Proposed plant species list comprising native and exotic species. Quantities of each species will be nominated at detailed drawings stage. Scheduled size to Honsby Shire Council requirements. Planting density to achieve bed coverage within 24 months.

Plant List	t						
ID	Qty	Common Name	Botanical Name	Scheduled Size	Mature Height	Mature Spread	Remarks
Trees							
BACcit	1	Lemon Myrtle	Backhousia citriodora	100lt	6m		
BACmyr	1	Grey Myrtle, Lancewood	Backhousia myrtifolia	100lt	5-10m		
BRAace	1	Illawarra Flame Tree	Brachychiton acerifolius	45lt	10m		
BRAcla	1	'Clarabelle'	Brachychiton acerifolius 'Clarabelle'	100lt	8m		
CASgla2	1	Grey (Swamp) She-oak	Casuarina glauca	native tube			
CERgum-1 ELAeum	1 1	NSW Christmas Bush Eumundii	Ceratopetalum gummiferum 'Alberys	100lt 45lt	1m 8m		
ELAeum	<u> </u> 1	Prima Donna	Elaeocarpus eumundii Elaeocarpus ret Prima Donna	45it	6m		
LIVaus	1	Cabbage-tree Palm	Livistonia australis	401t			
SYNglo	1	Turpentine	Syncarpia glomulifera	45lt	over 30m		
TRIlus	1	Luscious	Tristaniopsis 'Luscious' PBR	100lt	10m		
WODbif	1	Foxtail Palm	Wodyetia bifurcata	1001	5-10m		
Shrubs	•						
ACAdwa	1		Acacia fimbriata dwarf	140mm	1m	1m	
ACAmol	1	Oyster plant	Acanthus mollis	200mm	1.5m		
ACMche	1	Cherry Surprise	Acmena 'Cherry Surprise'	200mm	3-5m		
ALCrub	1	Giant Bromelliad	Alcantarea imperialis Rubra	300mm	1m		
ALObri	1	Elephant's Ear, Cunjevoi	Alocasia brisbanensis	200mm	0.9-1.5m		
BABmin	1	Dwarf Baeckia	Babingtonia vir. Miniature	140mm	1m		
BAEmtT	1		Baeckia Mt Tozer	140mm	1m		
BANbir	1		Banksia 'Birthday Candles'	200mm	0.6m		
BANrob	1	Swamp Banksia, Large-leaf Banks	Banksia robur	200mm	0.9-1.5m	1.2 - 2.0m	
BANpyg	1		Banksia serrata 'Pygmy Possum'	200mm	0.75m	2m	
BUXjap	1	Japanese Box	Buxus japonica	200mm	0.75m	0.5m	
CALcan	1	Pink Bottlebrush	Callistemon 'Candy Pink'	200mm	3m	2.5m	
CHAele	1	Parlour palm	Chamaedora elegans	200mm	2m		
CORpur	1	Cordyline	Cordyline 'Purple Sensation'	300mm	4m		
CORaus	1	Chocolate Dracaena Palm	Cordyline australis	200mm	5-6m		
CORpet	1		Cordyline petiolaris	200mm	4m		
CYAcoo	1	Tree Fern	Cyathea cooperii	300mm			
DORexc	1	Spear Lilly	Doryanthes excelsa/palmerii	300mm			
GARflo	1	Florida	Gardenia 'florida'	200mm			
GARoce PHIroj	1	Ocean pearl	Gardenia 'Ocean Pearl'	200mm 200mm	.7m		
PITmuf	1	Rojo Congo Miss Muffet	Philodendron 'Rojo Congo' Pittosporum tobira "Miss Muffet'	200mm			
RHAexc	1	Lady Palm	Rhapis excelsa	300mm	3 - 5m		
STRreg	1	Bird of Paradise	Strelitzia reginae	300mm			
THAxan	1	Xanadu	Thaumatophyllum 'xanadu'	200mm			
ZAMfur	1	Cardboard Palm	Zamia furfuracea	200mm	1m		
Ground Co	vers						
ALTden	1	Lesser Joyweed	Alternanthera dentata ' Little Ruby'	140mm	0.3-0.6m	0.3 - 0.6m	
CAScou	1		Casuarina glauca 'Cousin It'	140mm			
CLImin-1	1	Clivea	Clivea miniata Belgian hybrid	200mm			
GREgra	1		Grevillea 'Grassfire'	140mm	0.25m		
SCAaem	1	Blue Fanflower	Scaevola aemula 'Mauve Clusters'	140mm	0.3		
SEDliz	1	Autumn Joy Stonecrop	Sedum 'Lizard'	140mm	0.6-0.75m		
TRAtri	1	Tricolour Star Jasmine	Trachelospermum jasminoides 'Trico	140mm	0.75m	0.75m	
VIOhed	1	Native Violet	Viola hederacea	140mm	0.75m	0.75m	
Grasses							
DIAlit-1	1	Little jess	Dianella 'Little Jess'	140mm	0.6m	0.6m	
DIAcae	1	Dianella	Dianella caerulea	140mm	0.6m	0.6m	
ISOnod	1	Knobby Club-rush	Isolepis nodosa	Native Tube	0.6 - 0.75m	0.3 - 0.6m	
JUNusi	1	Common Rush	Juncus usitatus	Native Tube	0.9-1.5m		
LIRgnt	1	Giant Lilyturf	Liriope muscari 'Evergreen Giant'	140mm	0.5m		
LIRjus	1	Giant Lilyturf	Liriope muscari 'Just Right'	140mm		0.3-0.6m	
LIRwhi	1	Stripey White	Liriope muscari 'stripey white'	140mm	0.4m	0.4m	
Climbers							
PANwed	1	Wedding Bellz	Pandorea jasminoides 'Wedding Bel	l 200mm	3 - 5m	3.5 - 6m	
TRAjas	1	Star Jasmine	Trachelospermum jasminoides	200mm	3-5m	3.5-6m	
Ferns							
ASPaus	1	Bird's nest fern	Asplenium australasicum	200mm			
DOOasp	1	Prickly Rasp Fern	Doodia aspera	140mm	0.6-0.75m	0.3m	
Total	57						
<u> </u>		1	·	I		1	1

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Client Living Choice Australia
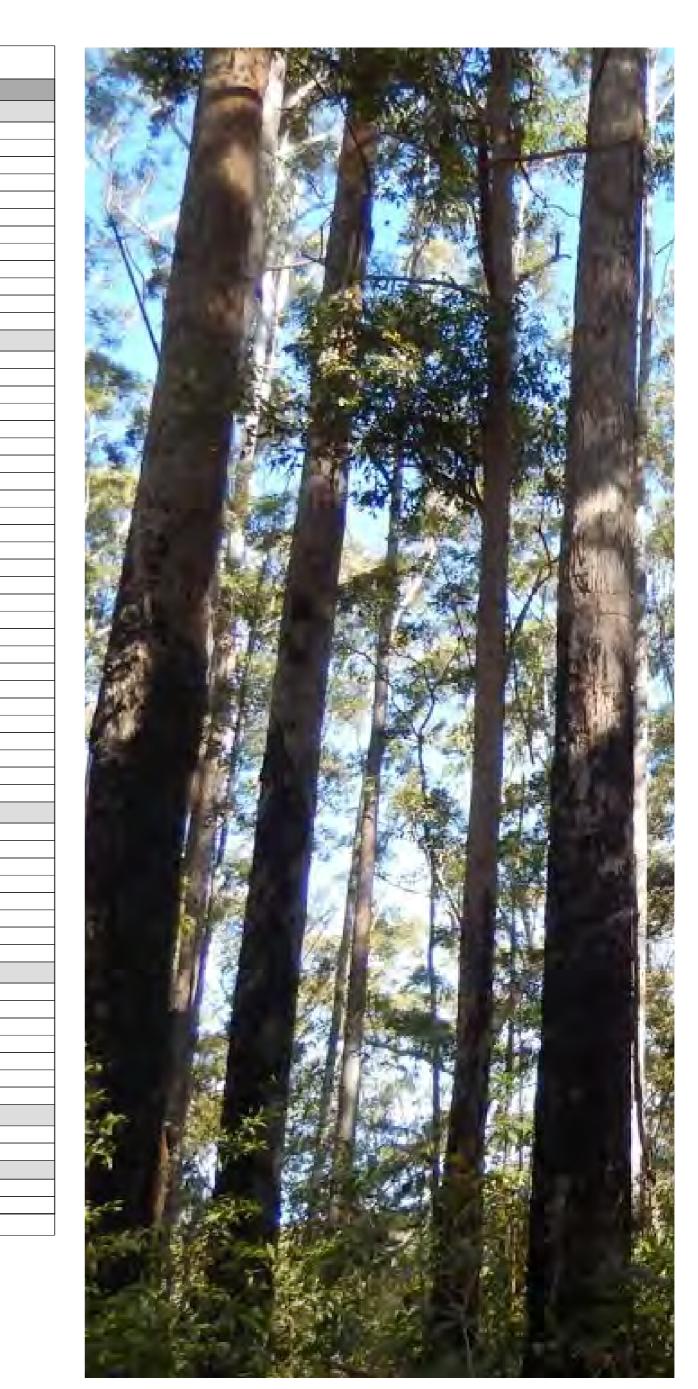
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Project Residential Choice

Drawing Schedule



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Scale
Date
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North
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Dwg No.
Sht-1

Trees



Backhouse citriodora

Stenocarpus sinuatus







Elaeocarpus reticulatus 'Prima Donna' Elaeocarpus eumundi

Livistona australis

Shrubs







Chamaedorea elegans







'Congo Rojo'

Philodendron Xanadu

Raphis excelsa

Ctenanthe setosa

Banksia Birthday Candles

Babingtonia sp

Climbers Grasses & Ground Covers







Sedum sediforme 'Silver'



Asplenium nidus



Liriope 'Just . Right'

Trachelospermum



Trachelospermum iasminoides 'Tricolour



Liriope muscari 'Evergreen Giant'



Ophiopogon 'Stripey White'



Viola hederacea

Dianella tasmanica 'Tasred'





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laurina

'Luscious'



Wodyetia bifurcata





NO. DATE NOTE Acacia fimbriata dwarf

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Drawing Plant images

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Scale		
Date 17.12.2	23	
North	Job No. LP22-34 Issue.	Dwg No. Sht-2

Callistemon Pink

Banksia robur



Dianella streetscape



Dianella caerulea 'Little Jess'

Pratia pedunculata

Scaveola 'Purple Fanfa



Dianella brevipedunculata
























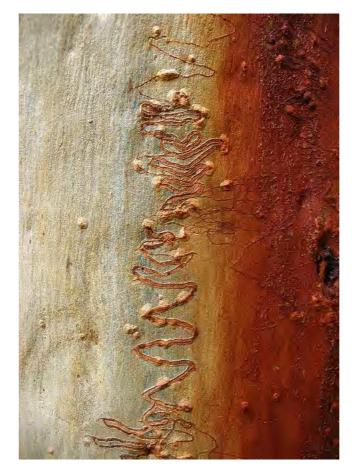

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Drawing Design Intent images 2



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Issue.

LP22-34

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Dwg No.

Sht-9







Scale

Date

North

17.12.23

This *revised* (June 2024) landscape concept document forms part of a Development Application for construction of an aged care and independent living residential development across eight towers at Quarry Rd Dural.

Site identity-

Described as Lot 2A in DP 158064 and Lot 1 in DP 230172, 3 Quarry Rd and 4 Vineys Rd Dural NSW and is within Hornsby local government area.

Cadastral survey plans show levels are AHD 208m at the north west corner on Quarry Rd descending north across the site to a central gully at approximately 200m AHD then rising to 205mAHD at the northern Vineys road boundary. The terrain also descends from the western boundary to a low height of 193m at the eastern boundary.

Presently the approximately 2.96 Ha site contains two residential dwellings and associated driveways and out buildings.

A portion of the site (NE corner) is nominated as a 'Blackbutt Gully forest' dominated by Turpentine trees (*Eucalyptus glomulifera*). These will be retained and rehabilitated following weed removal. The balance of the site comprises pasture grasses and an assortment of native and exotic vegetation. Reference is made to earlier Arboricultural assessments which describe plant communities in detail.

Adjacent landuse includes rural residential dwellings, plant nursery and ovals associated with a private school.

Landscape direction-

Landscape direction is governed by Hornsby local authority DCP policy 2.1.3 (Landscaping) with goals stated as 'Development in rural areas will be environmentally sustainable and protect and improve water quality, native flora and fauna, soil, air and other environmental values. Development will also protect and enhance the visual qualities and characteristics of the rural environment by being compatible with the scale, form, design, colour, height, materials, setbacks and landscaping of the surrounding rural area.'

Setbacks integrate the built form with landscaping and include screening from neighbouring properties on the western and eastern boundaries.

Landscaping also references Bushfire management plans where all weather access is provided to large fire fighting vehicles (structural grass cell), plants are selected on the basis of low flammability, have non contiguous planting arrangement and incorporate other measures as outlined in the RFS summary of January 2021.

Landscape initiatives in general terms reflect the local endemic vegetation type. Plantings are used to soften the building mass, provide texture, colour and resident amenity.

Amendments to the court approved plans include differing (improved) access roads, bridges/pathways and central plaza arrangement. Landscaping is modified to respond to these changes.

Landscape locations-

Landscaping is nominated on the site frontages (Quarry and Vineys Rd), western and eastern boundaries and southern boundaries adjoining the neighbouring nursery. Significant landscaping is proposed within the central paved plaza (podium deck).

1. *Site frontages* for street appeal. Concept plans (plan and isometric views) show the use of a range of plants that soften the built form and establish site identity in five beds along Quarry road corresponding to the vehicle crossovers. Vegetation height provided at maturity will assist in 'layering' the vegetation to the second level and above. Other plantings buffer the required built elements (pad mount, fire service booster cabinet and bin service where proposed on other's drawings). CPTED principles are observed. Night time lighting will be included. Similar plantings will be detailed for the Vineys Road side.

2. *Street tree planting* may include Syzygium, Ceratopetalum, Tristania Luscious and Pittosporum, endemic to the area.

3. *Site boundaries* are populated with medium shrubs to screen the development. On the western boundary a line of Elaeocarpus will be planted and provide a buffer and colourful hedge when flowering. On the southern facing boundaries planting of taller species (Allocasuarina) adjacent to the proposed rock lined swale will limit views into and out of the site. The use of endemic and native species diverges from the original design to one that is more harmonious with Hornsby Shire policy. The use of natives provides fauna habitat by way of food and nesting opportunities.

4. *Within the building precinct* some use of exotic species is indicated for reasons of diversity and colour.

5. *Internal roadways* are shown on the eastern and western sides of the site. The eastern roadway services the basement carparks and as shown on the site plan are surfaced alternately in concrete and turf cell. Turf cells may assist in limiting the extent of paved surfaces, reduce heat and provide visual appeal through differing surface textures. Lines of appropriately sized trees and shrubs flank this roadway. On the western road which is primarily designed for Fire Service vehicles, the surface is again segmented (concrete and turf cell). Screening plants are provided between this road and the buildings for privacy.

6. *Central plaza* is where an effort has been made to provide a more functional space. Turf areas have increased to promote cooling and decrease paved areas. Beds have been redesigned to allow better pedestrian access from the upper cafe level through to the main swale area down flights of steps or wheelchair ramps/lifts. The flanking beds will be of sufficient area, volume to support trees of modest habit (to 15m). Beds will be 400mm to 1m in height. It is anticipated that the trees will be pruned/maintained to provide a long view down this space. Seating against beds are also nominated in several areas. As the space is aligned north south and constrained either side by the proposed buildings, tree and shrub species tolerant of a semi shade aspect will be nominated at the detailed design stage.

7. *Main swale* runs North to South and bisects the site. Storm events may see overland flow through this constructed channel. It is anticipated that parent rock material will be excavated, cut appropriately to be reused for constructed beds within the channel. These constructed beds may be 2400mm in height and backfilled with suitable material to support the growth of riparian vegetation (Livistonia palms, Cyathea, hemholtzia, Lomandra) to emulate a natural plant association. The civil engineering design shows two bridges crossing this swale which should be a pleasing element of the overall design.

8. *The Blackbutt gully* is to be retained and rehabilitated. Rehabilitation includes the removal of weed species and the technique of assisted regeneration using endemic species. Plantings from the building precinct to the gully will transition from native/exotic to endemic. An informal surfaced serpentine pathway is also proposed through the gully area (detailed at construction drawing stage, similar to previous design).

In broad terms the landscaping proposed is appropriate for the climate, provides visual interest and uses plant species that minimise the building bulk. Species are durable and therefore require minimal maintenance.

At maturity the landscaping should be a pleasing element to the street and to neighbours alike. Landscaping for the site will accord with current Hornsby Shire Council landscape requirements and be a positive element to the development.



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